

March 4, 2025

Jim McNamara
Southern Oregon University
1250 Siskiyou Blvd
Ashland, OR 97520

Re: SOU Center for the Visual Arts – Existing Roof Capacity for PV Panels

Dear Jim:

We have completed the structural evaluation of the existing roofs of the Art and Commons buildings to support PV panels. The evaluation included the existing steel roof trusses, framing members, structural roof decking, and the connection of the existing standing seam decking to metal roof decking. We understand the PV panels will be Silfab Solar's SIL-520 XM Bifacial panels weighing 2.3 psf and will be attached to the existing standing seam decking using aluminum rails and an S-5 Clamp system.

The evaluation was based on the requirements of the 2022 Oregon Structural Specialty Code (based on 2021 IBC). Our analysis relied on existing structural drawings, site photos, and field measurement of screw spacing provided by SOU.

Our findings confirm that the existing roofs of the Art and Commons buildings are capable of supporting above outlined PV system provided the minimum S-5 clamp spacing be as noted on attached site plan. The indicated minimum clamp spacing is required due to limited screw connections of the existing standing seam to the structural roof decking. The increased clamp layout will help spread the load more uniformly to the existing screws.

Engineering of the PV panels, rails, and clamps is by others.

If you have any questions or need further information, please call me.


Sincerely,



Chris Tung, PE, SE LEED AP
Associate

Project No. 10022500087



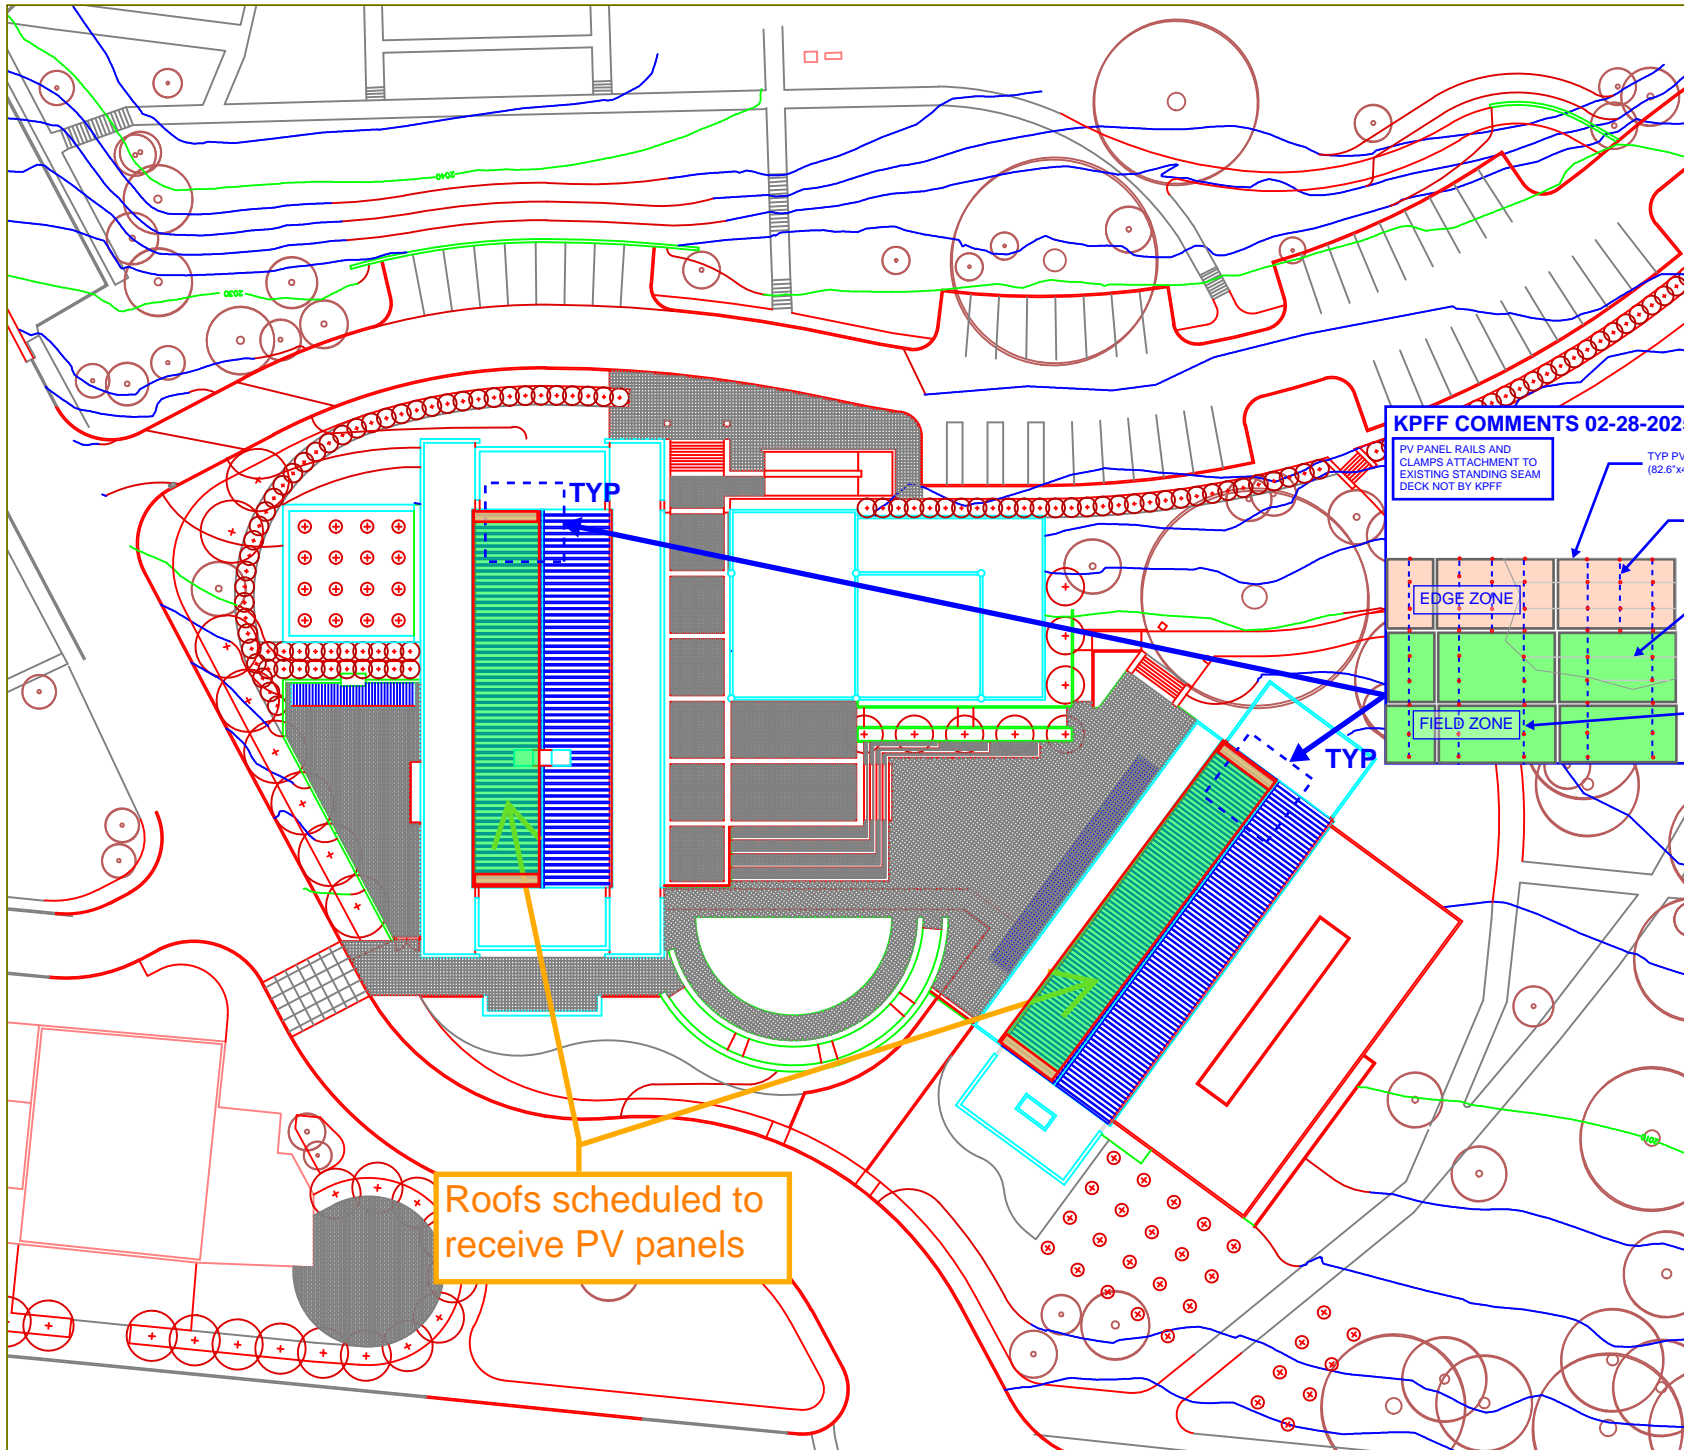

KPFF COMMENTS 02-28-2025


PV PANEL RAILS AND CLAMPS ATTACHMENT TO EXISTING STANDING SEAM DECK NOT BY KPFF

TYP PV PANEL (82.6"x44.6")

PROVIDE (3) RAILS AND CLAMPS TO STANDING SEAM AT EACH RIB (AT 16" o.c. FIELD VERIFY) AT EDGE ZONE

EXISTING STANDING SEAM DECK RIBS (AT 16" o.c. FIELD VERIFY) TYP

PROVIDE (2) RAILS AND CLAMPS TO STANDING SEAM AT EACH RIB (AT 16" o.c. FIELD VERIFY) AT FIELD ZONE

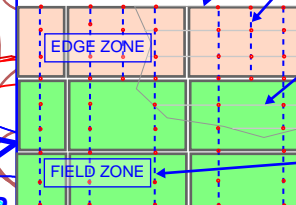

Roofs scheduled to receive PV panels



**BID DOCUMENTS
SITE PLAN**

**SOUTHERN OREGON UNIVERSITY
CENTER FOR THE VISUAL ARTS**

THOMAS HACKER AND ASSOCIATES
ARCHITECTS P.C.
210 S.W. 10TH AVENUE, SUITE 400
PORTLAND, OREGON 97204
(503) 222-1000

SEVP
STRUCTURAL & CIVIL ENGINEERS
1010 N.W. 10TH AVENUE, SUITE 200
PORTLAND, OREGON 97204
(503) 222-1000

CEM CONSULTING ENGINEERS, INC. -
MECHANICAL & ELECTRICAL ENGINEERS
2000 N.W. 10TH AVENUE, SUITE 200
PORTLAND, OREGON 97204
(503) 222-1000

REVISION 1

DATE 1 FEBRUARY 1, 2025

SCALE 1 1/8"=1'-0"

SHEET NO. A1.1

**THOMAS HACKER
AND ASSOCIATES
ARCHITECTS P.C.**

